




WALL TYPE 1

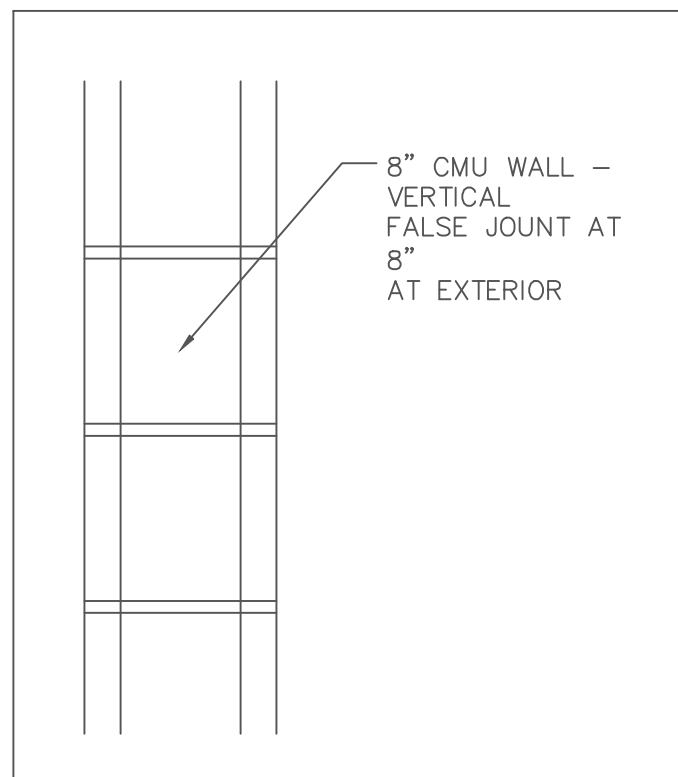


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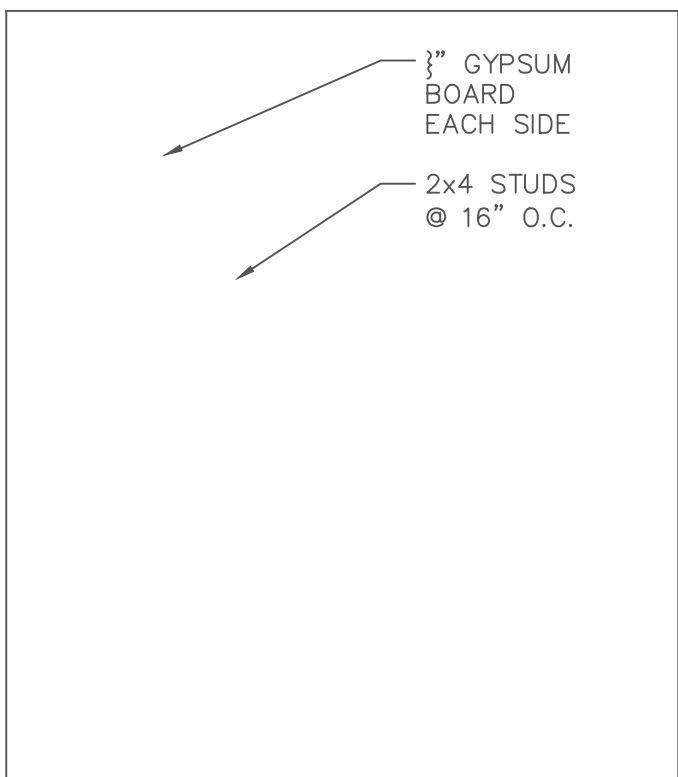
WALL TYPE 3

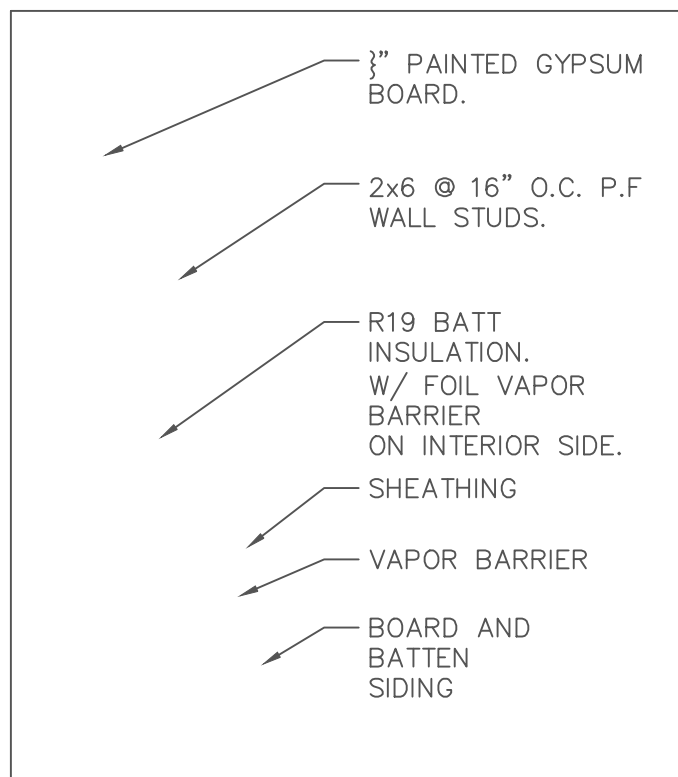

WALL TYPE 4

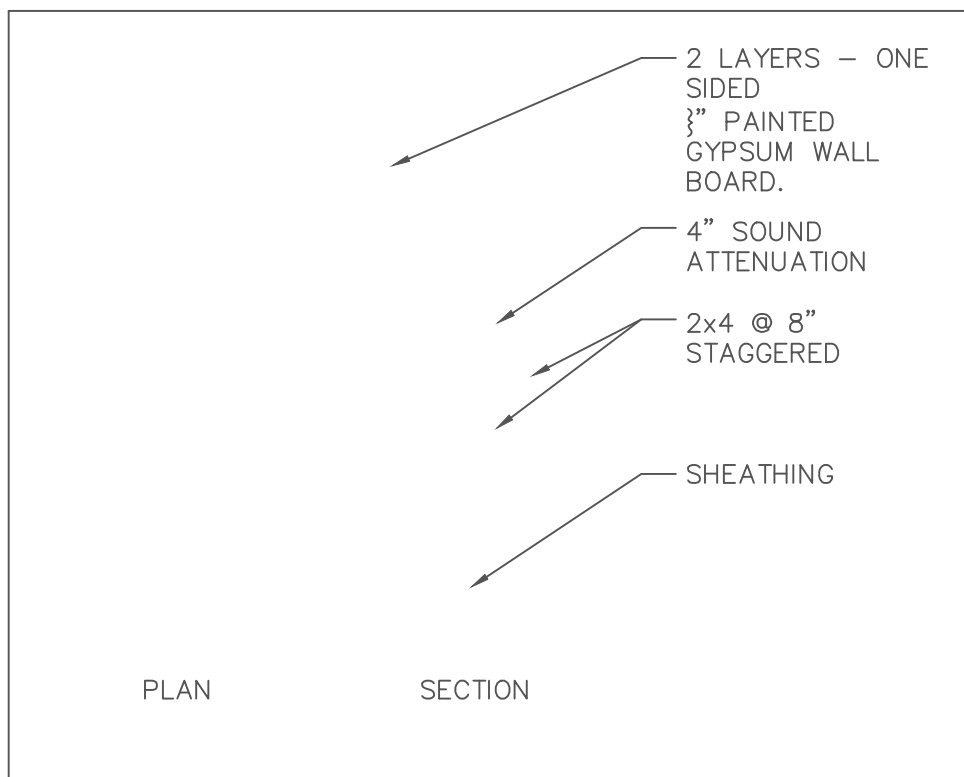

WALL TYPE 5

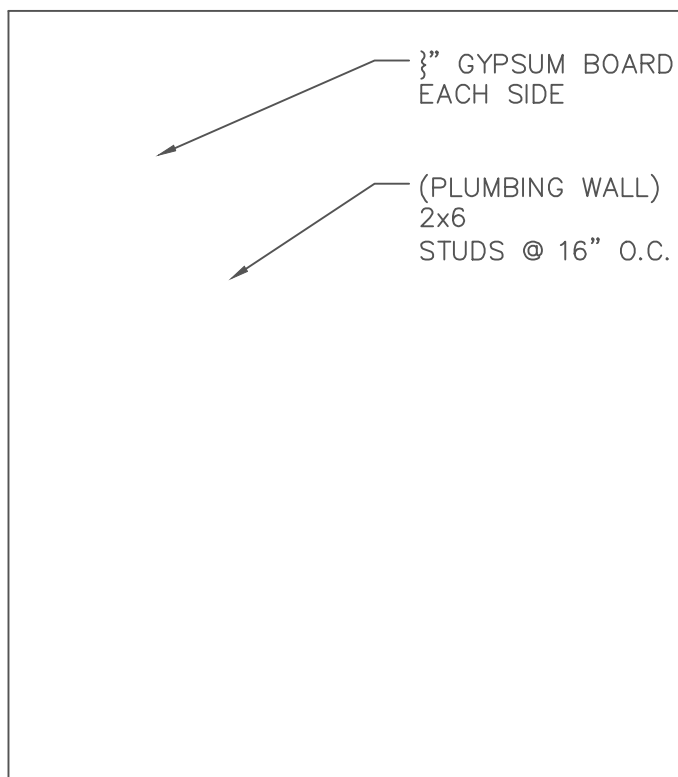


WALL TYPE 6

GENERAL NOTES

- DIMENSIONS SHALL BE TO EDGE OF CONCRETE, CENTER OF COLUMNS, EDGE OF ROUGH FRAMING, SHEATHING, CENTER OF DOORS, AND CENTER OF WINDOWS IN STUD WALLS AND EDGE OF MASONRY OPENINGS.
- MECHANICAL, ELECTRICAL AND AUTOMATIC FIRE SPRINKLER PLANS AND SPECS TO BE SUBMITTED TO CITY FOR REVIEW AND APPROVAL PRIOR TO CONSTRUCTION.
- ALL EXPOSED MECHANICAL VENTS AND GRILLES TO BE PAINTED. COLOR COORDINATE WITH WALL OR CEILING COLOR.

FINISH SYMBOL

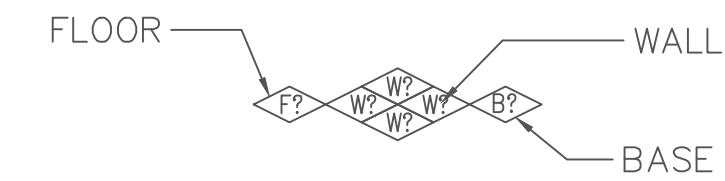

WALLS

- W1 PAINTED MEDIUM TEXTURE GYPSUM BOARD.
- W2 WATER RESISTANT PAINTED MEDIUM TEXTURE GYPSUM BOARD.
- W3 CERAMIC TILE
- W4 EXPOSED CONCRETE MASONRY UNITS.

FLOORS


- F1 EXPOSED CONCRETE

- BASE A 4" RUBBER COVE BASE

KEYNOTES

- PAVING - REFER TO CIVIL PLANS
- ADA ENTRANCE
- 4" CONCRETE SLAB ON 4" FREE DRAINING GRAVEL EXPOSED SOIL 8" BELOW T.O. SLAB (SEWER ACCESS)
- 2x6 @ 16" O.C. PLUMBING CHASE WALL.
- 2x4 @ 8" STAGGERED PARTY WALL.
- BUILT IN MDF HIGH DENSITY CABINETRY. TYPICAL.
- BUILT IN HIGH DENSITY MBF STORAGE. TYPICAL.
- (5) 14" DEEP VARNISHED HIGH DENSITY SHELVING SPACED AT 18".
- ROOF EDGE ABOVE. TYPICAL.
- 1 1/2" THICK SOLID CORE H.B. SLAB DOOR.
- METAL FRAME/ GLASS DOOR.
- EQUIPMENT.
- LOCKERS.
- MECHANICAL FURNACE.
- WATER HEATER
- 1-HR RATED SHAFT ABOVE CONTINUOUS TO ROOF CHIMNEY ENCLOSURE.
- BOILER UNIT
- CONDENSER UNIT.
- GAS METER LOCATION.
- GAS FIREPLACE OPEN ON BOTH SIDES.
- ELECTRICAL PANELS.
- VENT

DOOR SYMBOL

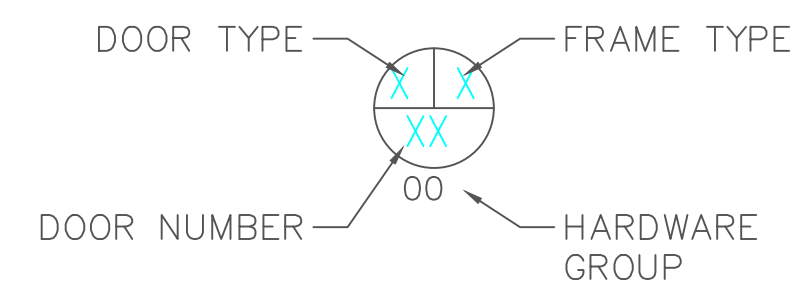

WINDOW SYMBOL



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(801) 363-1511 (801) 363-1560 Fax

CONSULTANTS

CIVIL - STANTEC CONSULTING
LANDSCAPE - 10TH MN. LANDSCAPE AND DESIGN

RAIL CENTRAL BUILDING THREE

1790 BONANZA DRIVE - LOTA
PARK CITY, UTAH

CENTURA RAIL CENTRAL
OWNER


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	07/05/02	

PROJECT NUMBER: 2002-08
DRAWING FILE: DWGS/CD/SAP102-SECOND LEVEL.DWG
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SHEET TITLE
SECOND FLOOR PLAN

AP102

OF

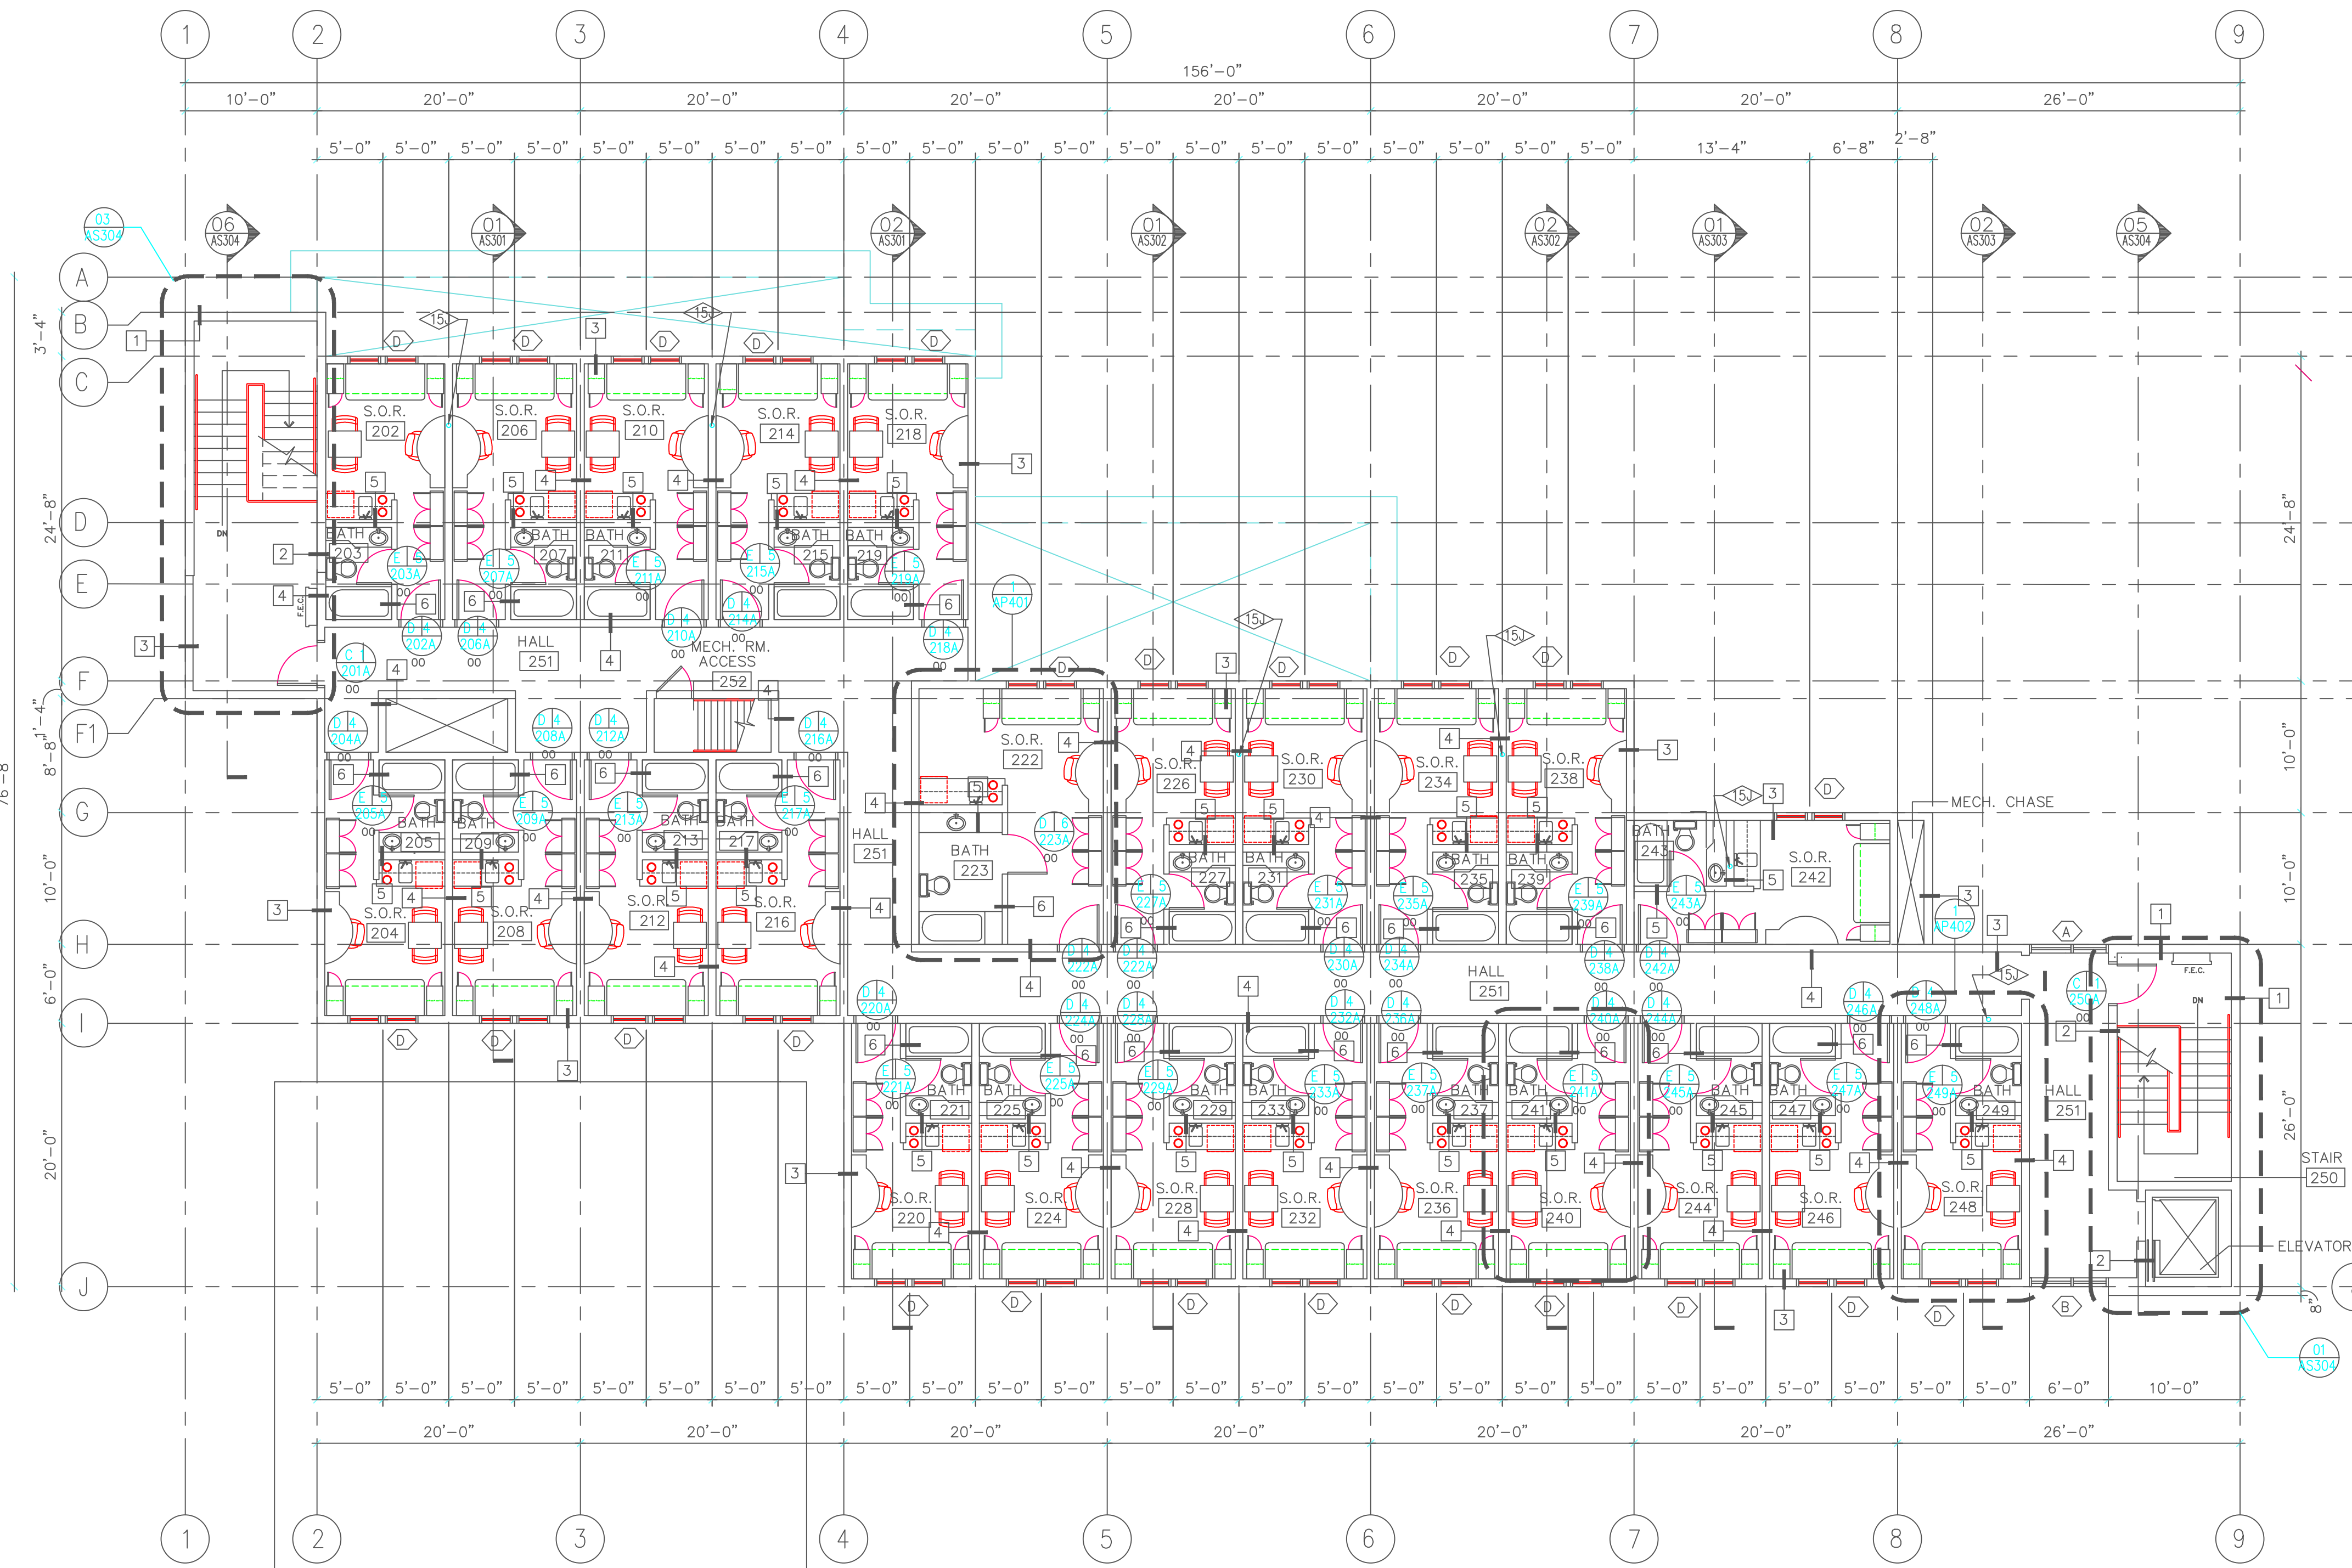

01 SECOND LEVEL FLOOR PLAN
AP102 SCALE: 1/8" = 1'-0"

